








THOMAS ISAKSSON	Do not scale drawings. Use figured dimensions only.	Morrison House	dwg:	SITE PLAN	AO1	job no. 0193
ARCHITECTURE + PROJECT MANAGEMENT 4/113 RESERVOIR STREET, SURRY HILLS, NEW SOUTH WALES. 2011.	Check all dimensions on site. Report discrepancies to architect.	14 The Crescent, Vaucluse	scale:	date:	issue:	rev:
architect 5692 registered in NSW - thomasolofisaksson@gmail.com - 0409 177 962	14 The Crescent, Vaucluse	1:200	DEC 2021	development application		

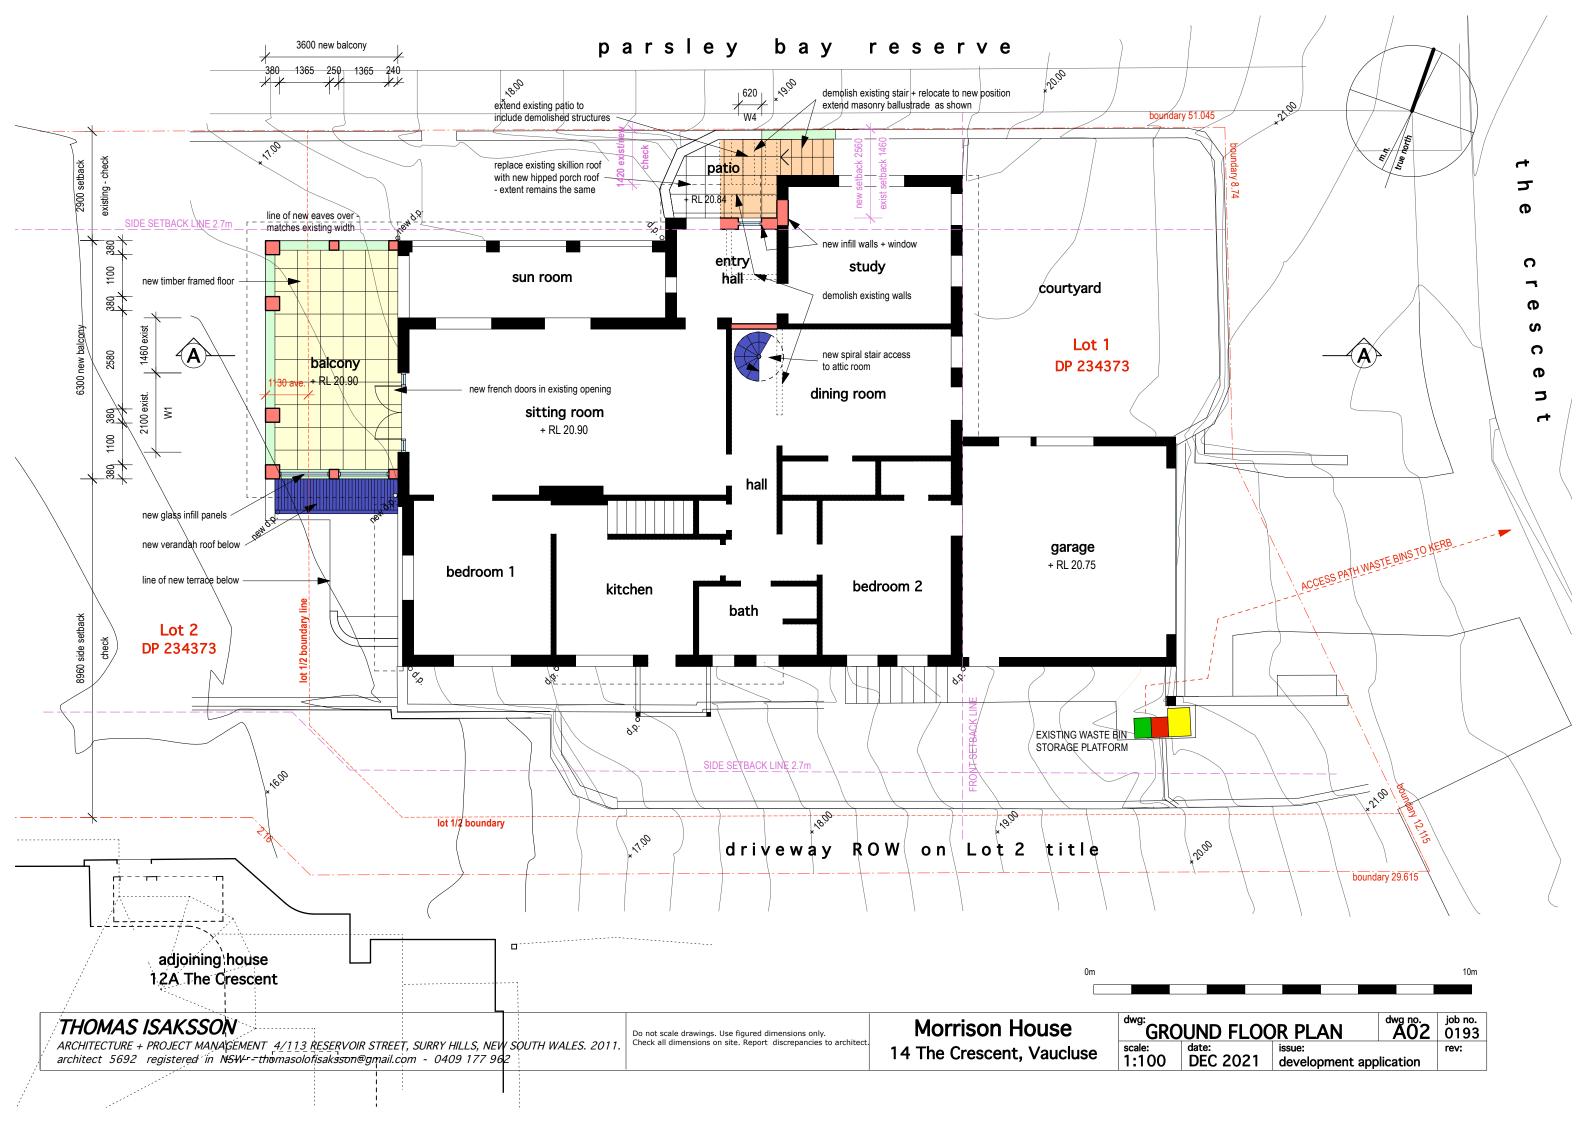

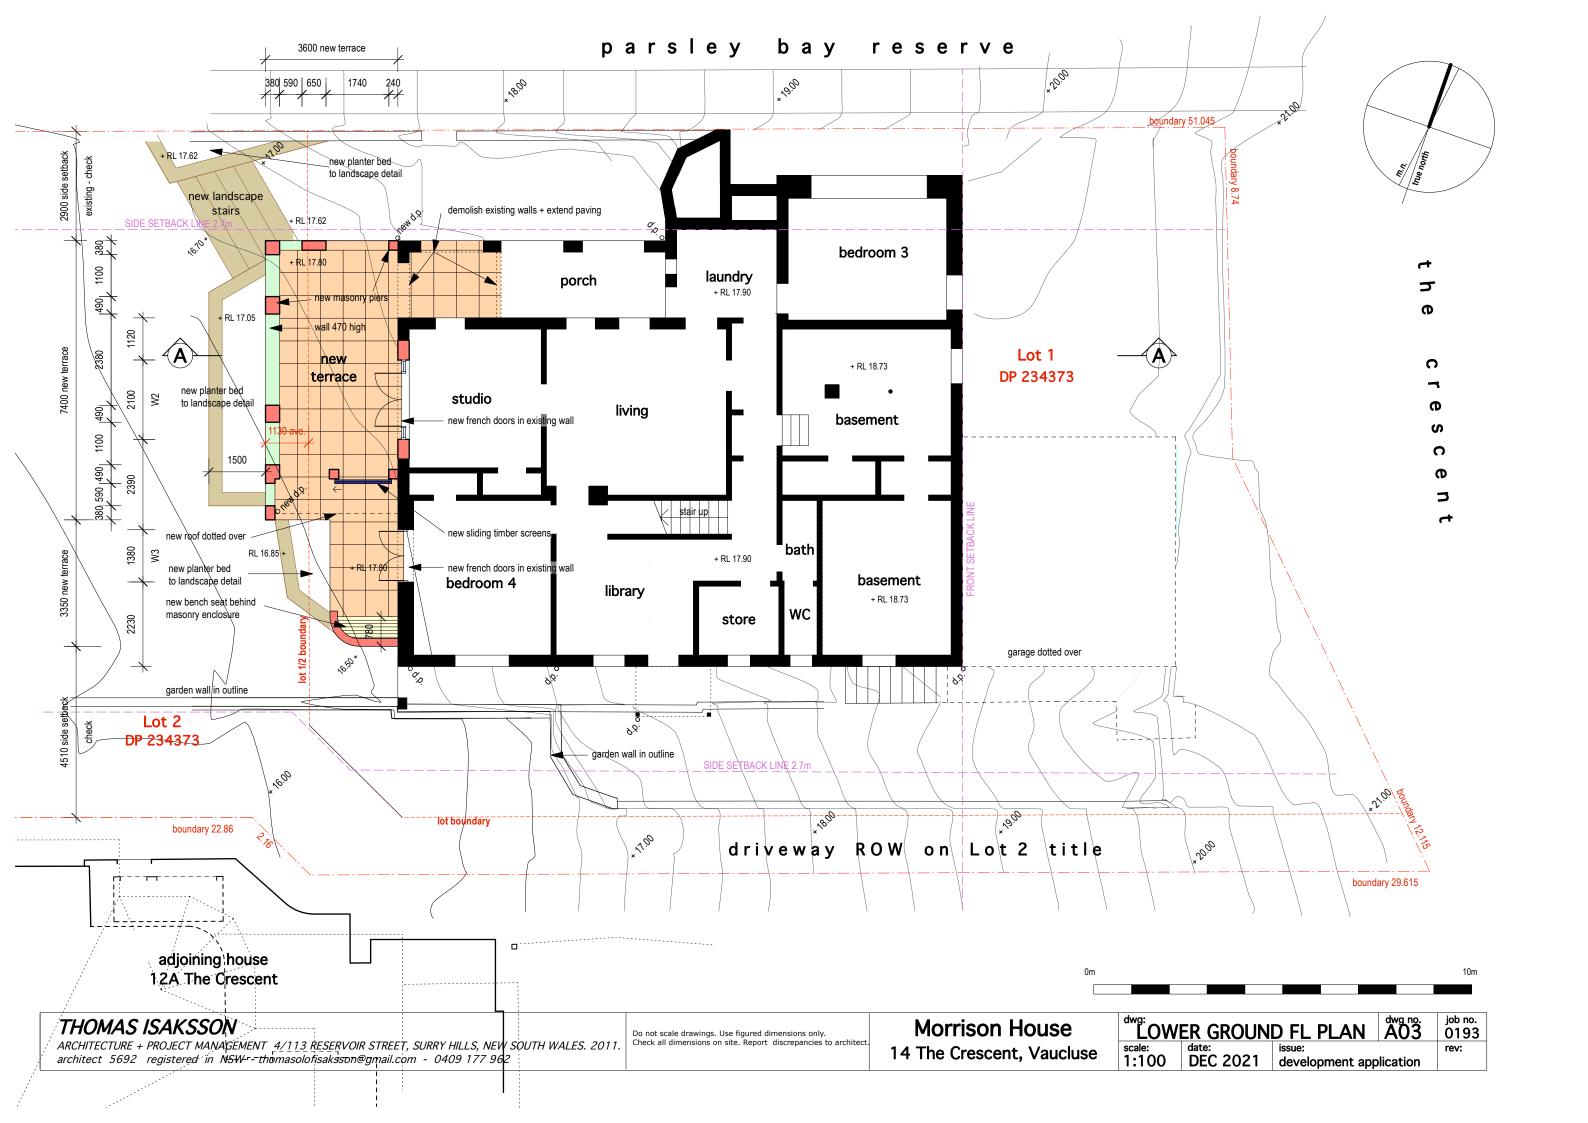

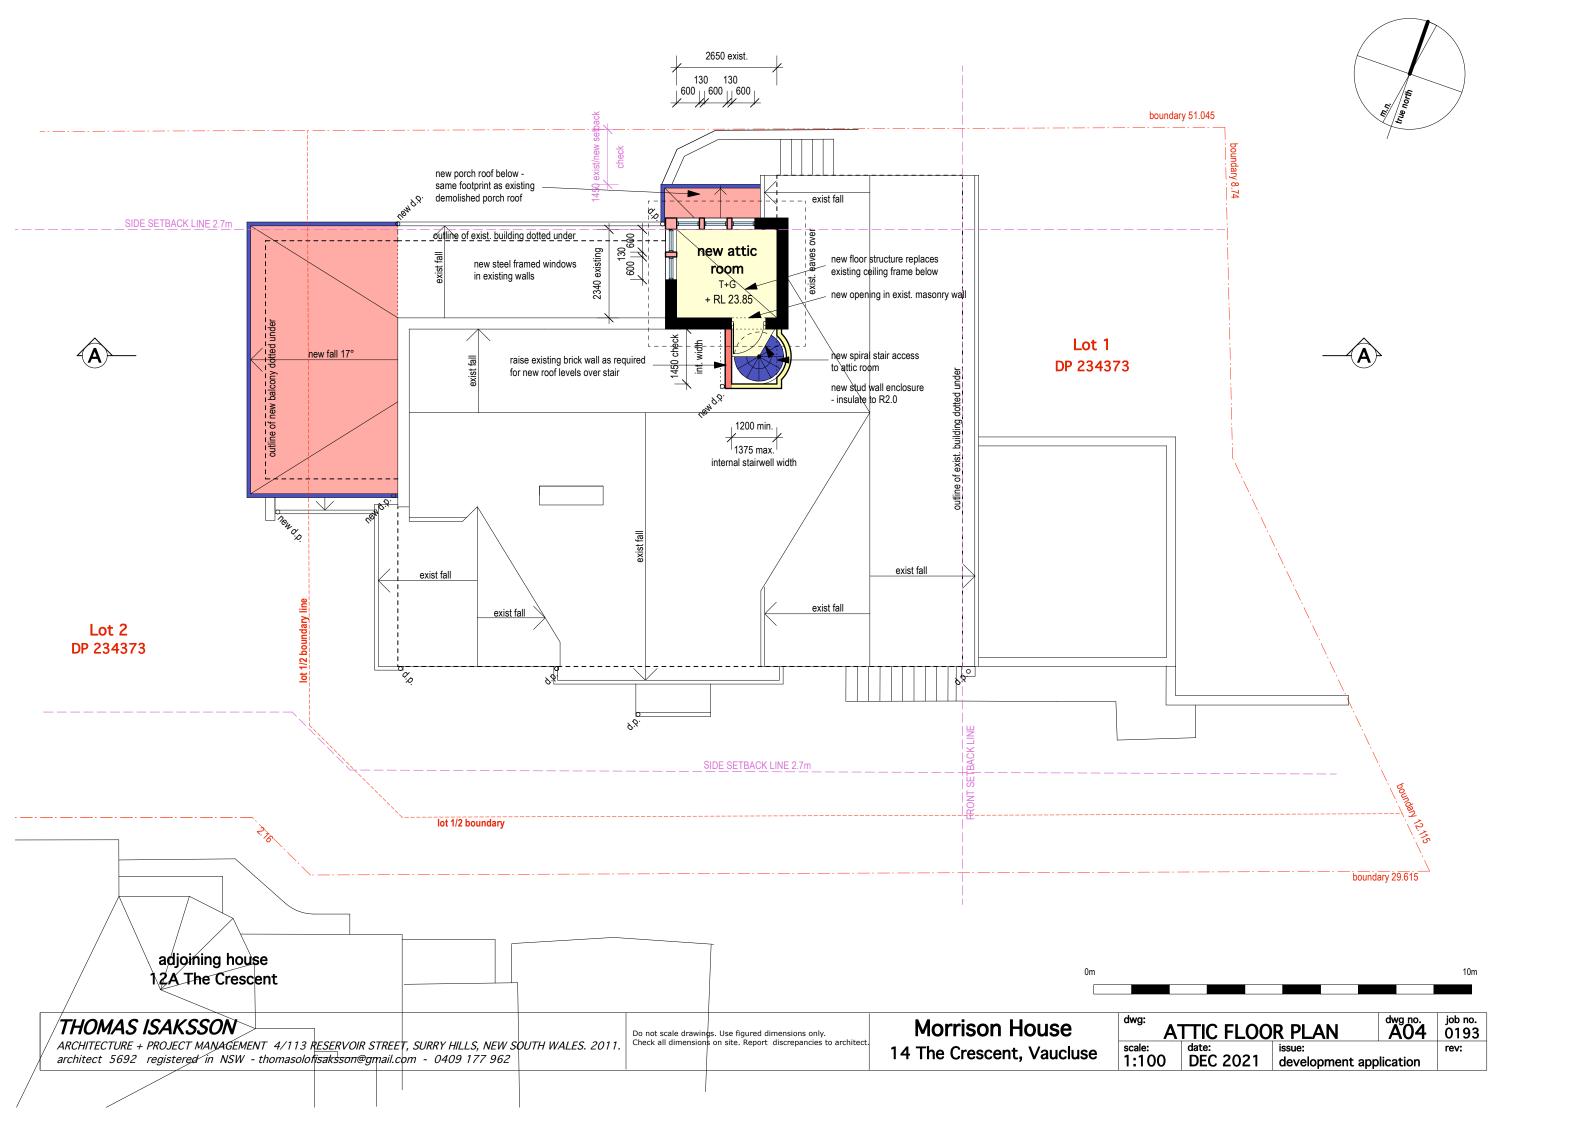

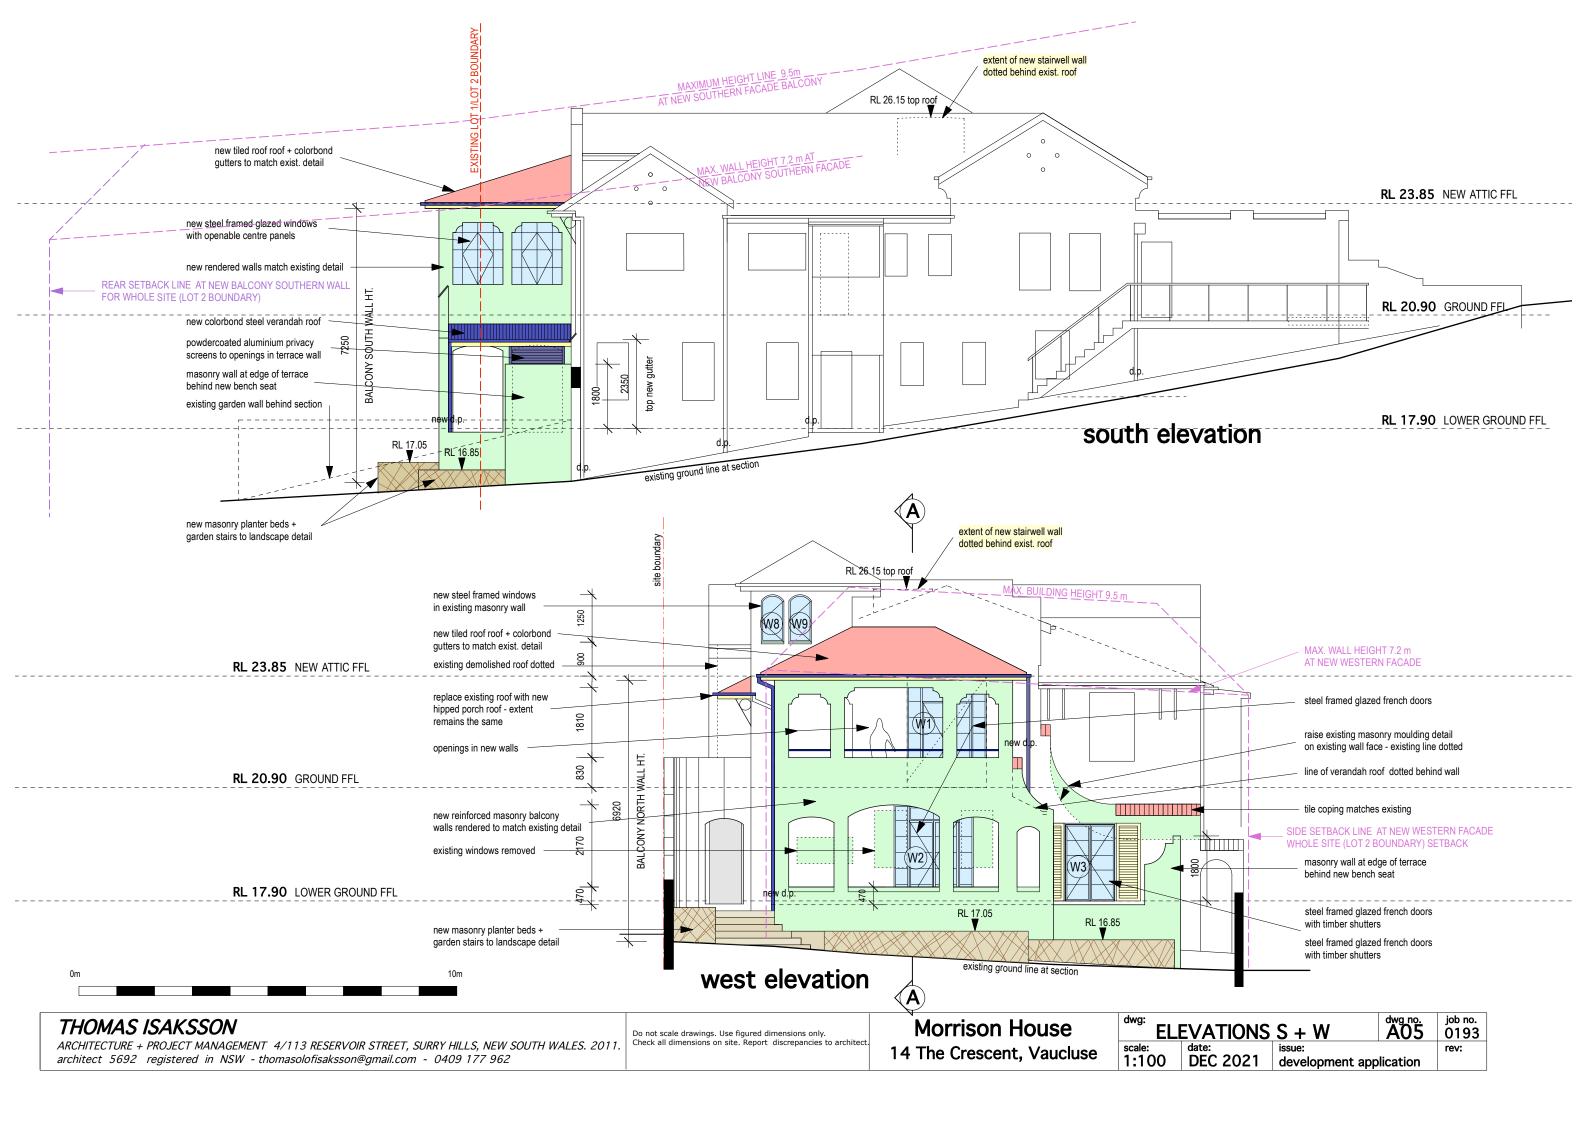

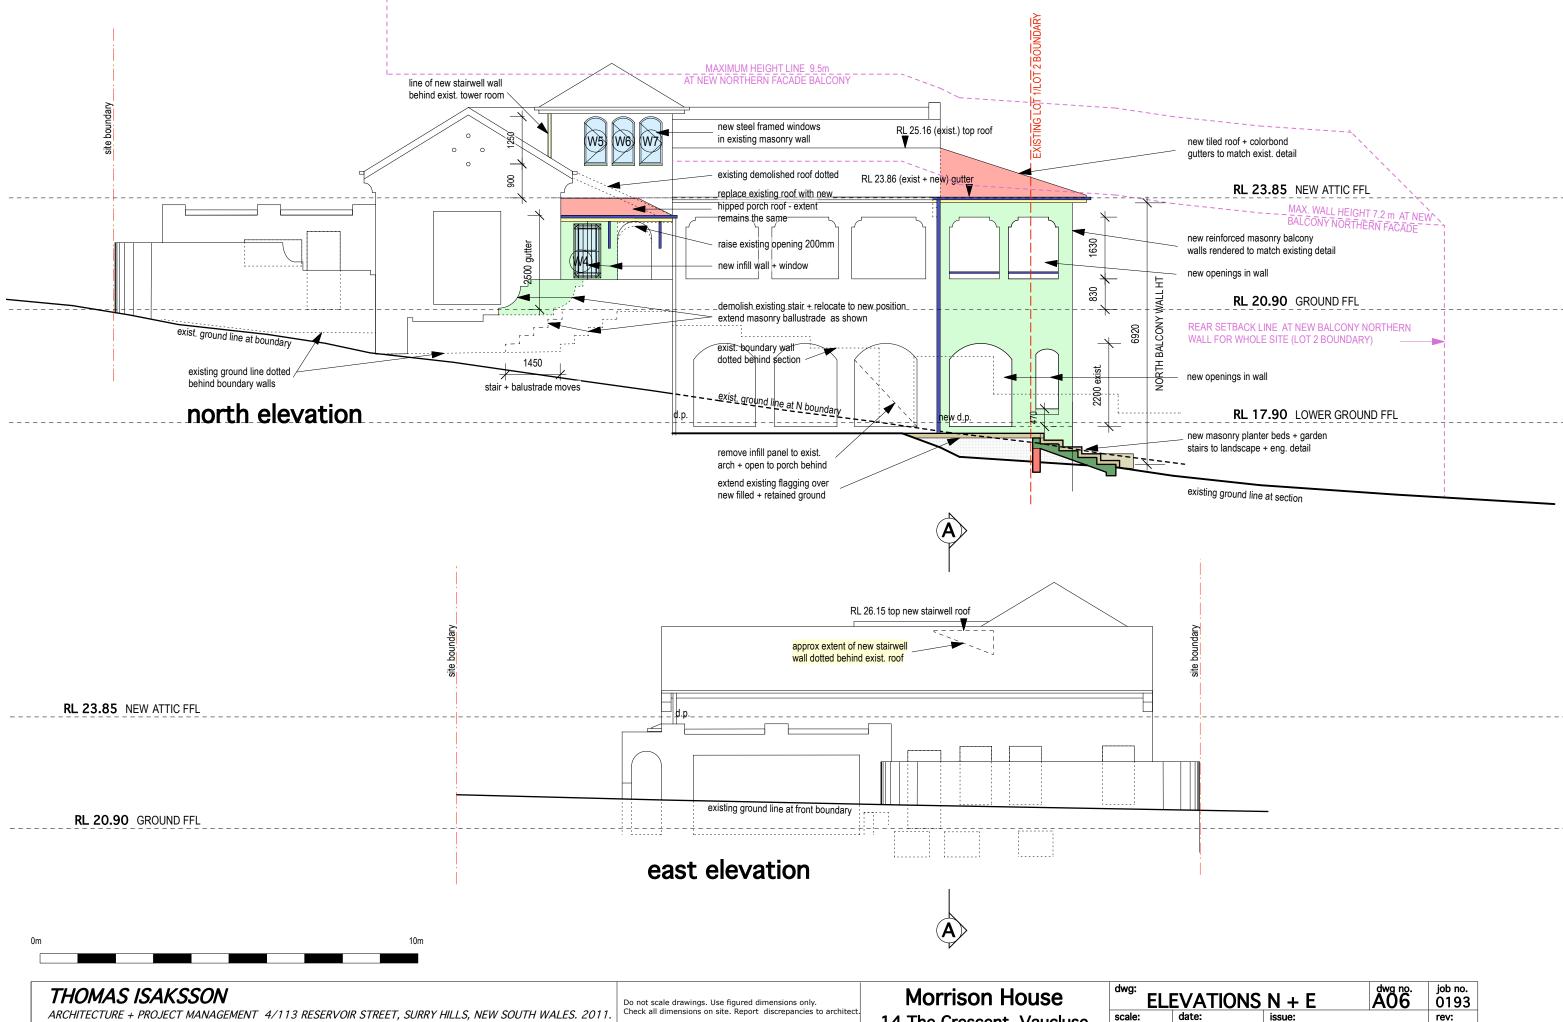

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BASIX certificate A440655 - glazing requirements

Window / door	Orientation	Area of	Overshadowing		Shading device	Frame and glass type	
no.		glass inc. frame (m2)	Height (m)	Distance (m)			
W1	W	6.1	0	0	projection/height above sill ratio >=0.43	standard aluminium, single clear, (or U-value: 7.63, SHGC: 0.75)	
W2	W	5.3	0	0	projection/height above sill ratio >=0.43	standard aluminium, single clear, (or U-value: 7.63, SHGC: 0.75)	
W3	W	2.8	0	0	external louvre/blind (adjustable)	standard aluminium, single clear, (or U-value: 7.63, SHGC: 0.75)	
W4	N	8.0	0	0	projection/height above sill ratio >=0.43	timber or uPVC, single clear, (or U-value: 5.71, SHGC: 0.66)	
W5	N	0.7	0	0	projection/height above sill ratio >=0.36	standard aluminium, single clear, (or U-value: 7.63, SHGC: 0.75)	
W6	N	0.7	0	0	projection/height above sill ratio >=0.36	standard aluminium, single clear, (or U-value: 7.63, SHGC: 0.75)	
W7	N	0.7	0	0	projection/height above sill ratio	standard aluminium, single clear, (or	
					>=0.36	U-value: 7.63, SHGC: 0.75)	
W8	W	0.7	0	0	projection/height above sill ratio >=0.36	standard aluminium, single clear, (or U-value: 7.63, SHGC: 0.75)	
W9	w	0.7	0	0	projection/height above sill ratio >=0.36	standard aluminium, single clear, (or U-value: 7.63, SHGC: 0.75)	

ARCHITECTURE + PROJECT MANAGEMENT 4/113 RESERVOIR STREET, SURRY HILLS, NEW SOUTH WALES. 2011.

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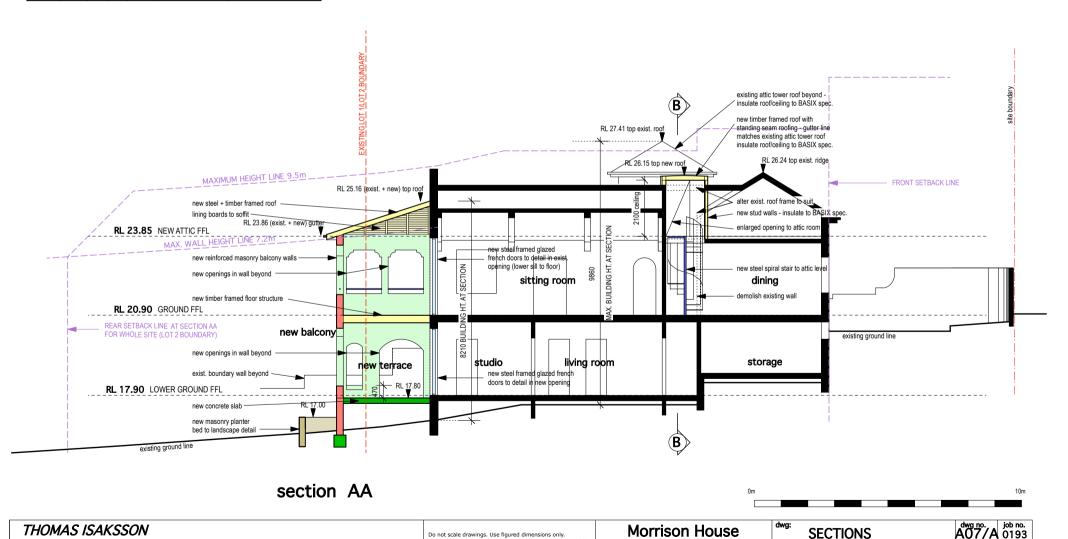
BASIX certificate A440655 - insulation requirements

scale: 1:100


DEC 2021 development application

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Construction	Additional insulation required (R-value)	Other specifications		
external wall: reverse brick veneer	R1.16 (or R1.70 including construction)			
external wall: framed (weatherboard, fibro, metal clad)	R1.30 (or R1.70 including construction)			
raked ceiling, pitched/skillion roof: framed	ceiling: R2.50 (up), roof: foil/sarking	dark (solar absorptance > 0.70)		
flat ceiling, flat roof: framed	ceiling: R1.58 (up), roof: foil backed blanket (55 mm)	medium (solar absorptance 0.475 - 0.70)		



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DEC 2021 development application

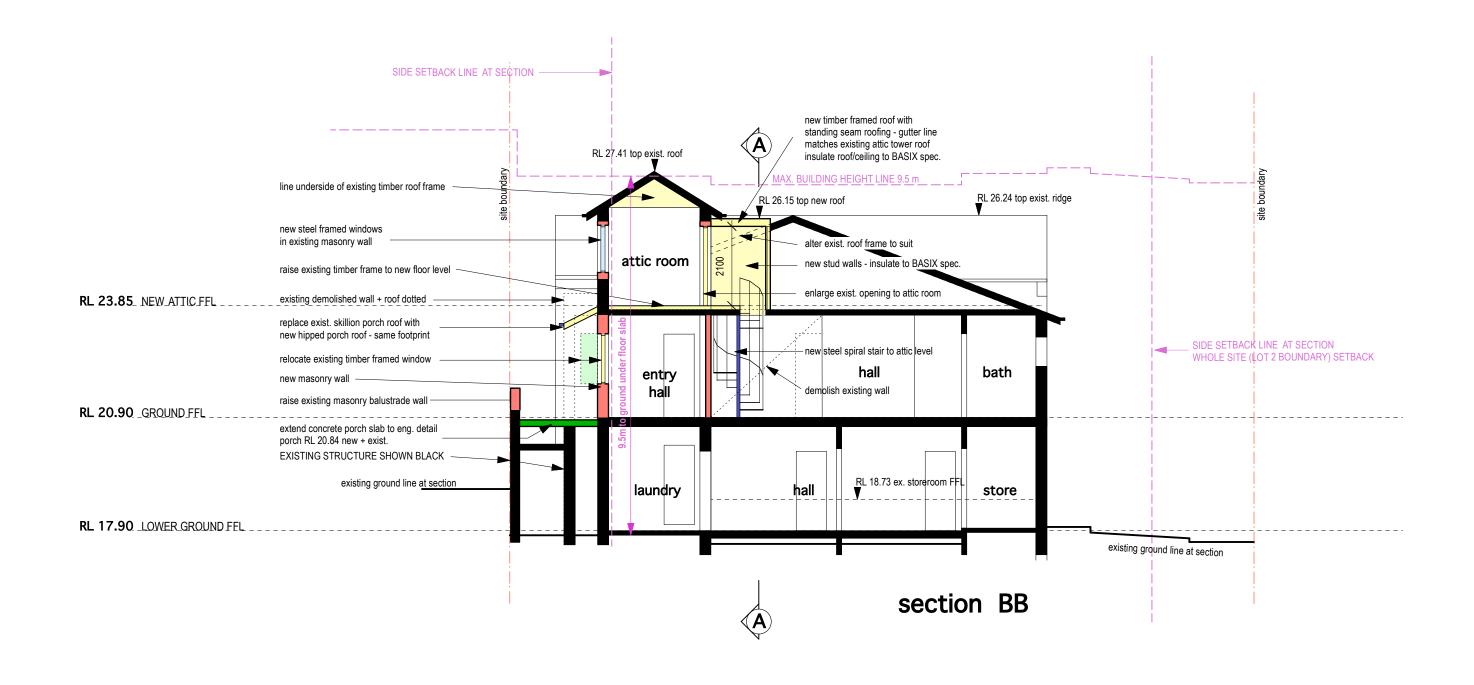

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Do not scale drawings. Use figured dimensions only. Check all dimensions on site. Report discrepancies to architect. Morrison House
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EXTERNAL FINISHES

dwg no. job no. 0193 rev:

scale: date: development application